WINCHESTER HIGH SCHOOL SURFACE APPLIED CORROSION INHIBITOR

80 SKILLINGS ROAD WINCHESTER, MA 01890



SHEET LIST

G100	COVER SHEET
S100	LEVEL 1 ACCESSIBILITY PLAN
S101	BASEMENT LEVEL ACCESSIBILITY PLAN
S200	SACI PLAN - BUILDING A
S201	SACI PLAN - BUILDING B
S202	SACI PLAN - BUILDING C
S203	SACI PLAN - BUILDING D
S204	SACI PLAN - BUILDING D/E
S205	SACI PLAN - BUILDING E
S300	TYPICAL SACI DETAIL

GENERAL NOTES

A. SPECIFICATIONS

SPECIFICATIONS
 Refer to project specifications for detailed requirements for materials and workmanship.

B. DRAWINGS

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b. International Building Code (IBC), International Code Council.

All dimensions and elevations are based on as-built drawings provided by the Town of Winchester. Existing conditions shall be verified in the field by the Contractor and any discrepancies shall be brought to the attention of the Engineer for clarifications before proceeding with the affected part of No.

C. GOVERNING BUILDING CODES
1. The following building codes and standards including all specifications referenced within shall apply to the design, construction, quality control, and safety of all work performed on the project.
a. Massachusetts State Building Code, 10th edition.

1. All work must be coordinated with the Town of Winchester and Winchester High School so as to not adversely affect or impact the operating hours of the high school.
E. Construction

The Drawings represent the completed project in which has been designed for the scope of work listed below. It is the Contractor's responsibility to determine and provide proper worker access and equipment to execute the work.
 In case of conflict between the general requirements, the specifications, and the details, the most restrictive shall govern.
 Contractor is responsible for means and methods of construction. Developing and implementing job site safety and construction procedures are the sole responsibility of the Contractor.

4. Contractor is responsible for protecting pedestrian walking paths and egress areas from risk of trip hazards. Cable protectors are the

responsibility of the Contractor.
5. If required, obtain all necessary permits for the work. The Contractor shall pay for all fees associated with this work.

c. Minimum Design Loads for Building and Other Structures (ASCE 7), American Society of Civil Engineers.

Surface Applied Corrosion Inhibitor:
 a. MCI 2020 V/O by Cortec MCI, St Paul, Minnesota

G. SCOPE OF WORK

1. Apply corrosion inhibitor at the following location:

2. Lymp Sym Pagic: LEVEL 1 underside where readily access

a. Lump Sum Basis: LEVEL 1 underside, where readily accessible as noted on plan.b. Unit Price Basis: LEVEL 1 underside, flood-prone areas as noted on plan.

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> 80 Skillings Road Winchester, MA 01890

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COVER SHEET

Drawing

Project No.
231066.04 Checked Date
02/XX/25

Drawn Approved SPC GGC

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KEY PLAN

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No. Date Description E

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LEVEL 1
ACCESSIBILITY PLAN

Drawing Title

Seal

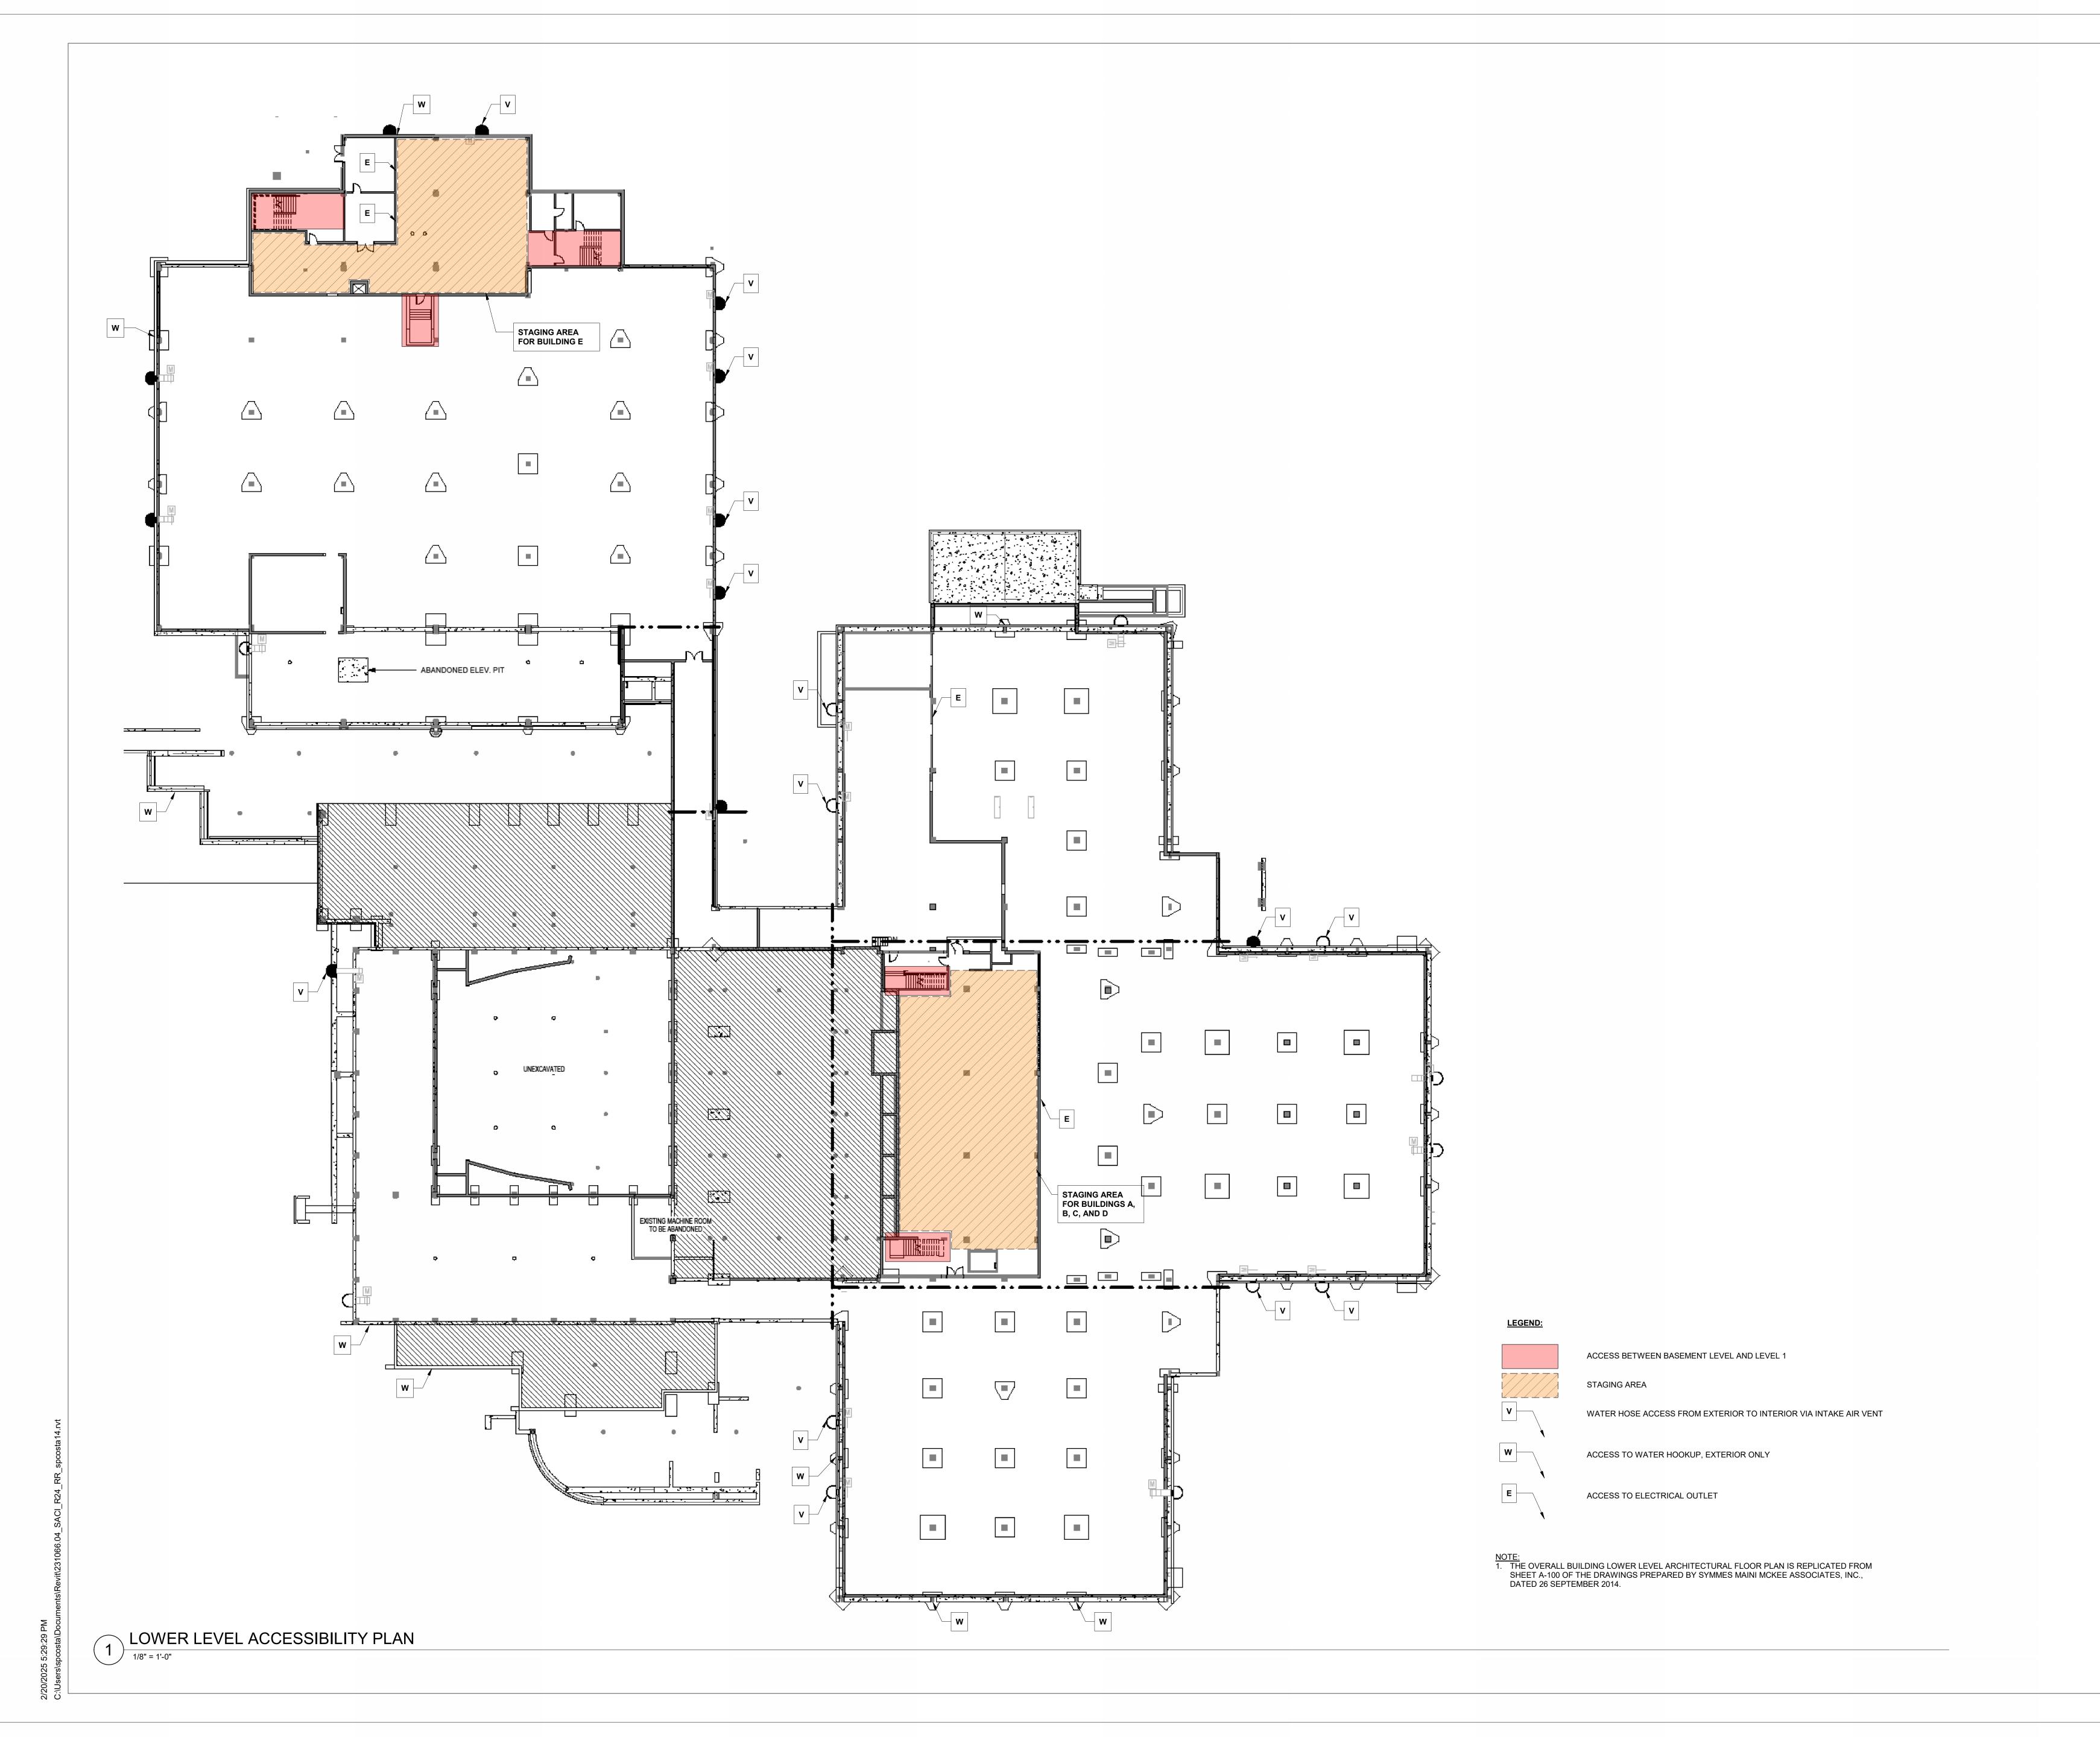
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Drawn
SPC

Drawing No.

S100





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KEY PLAN

No. Date Description

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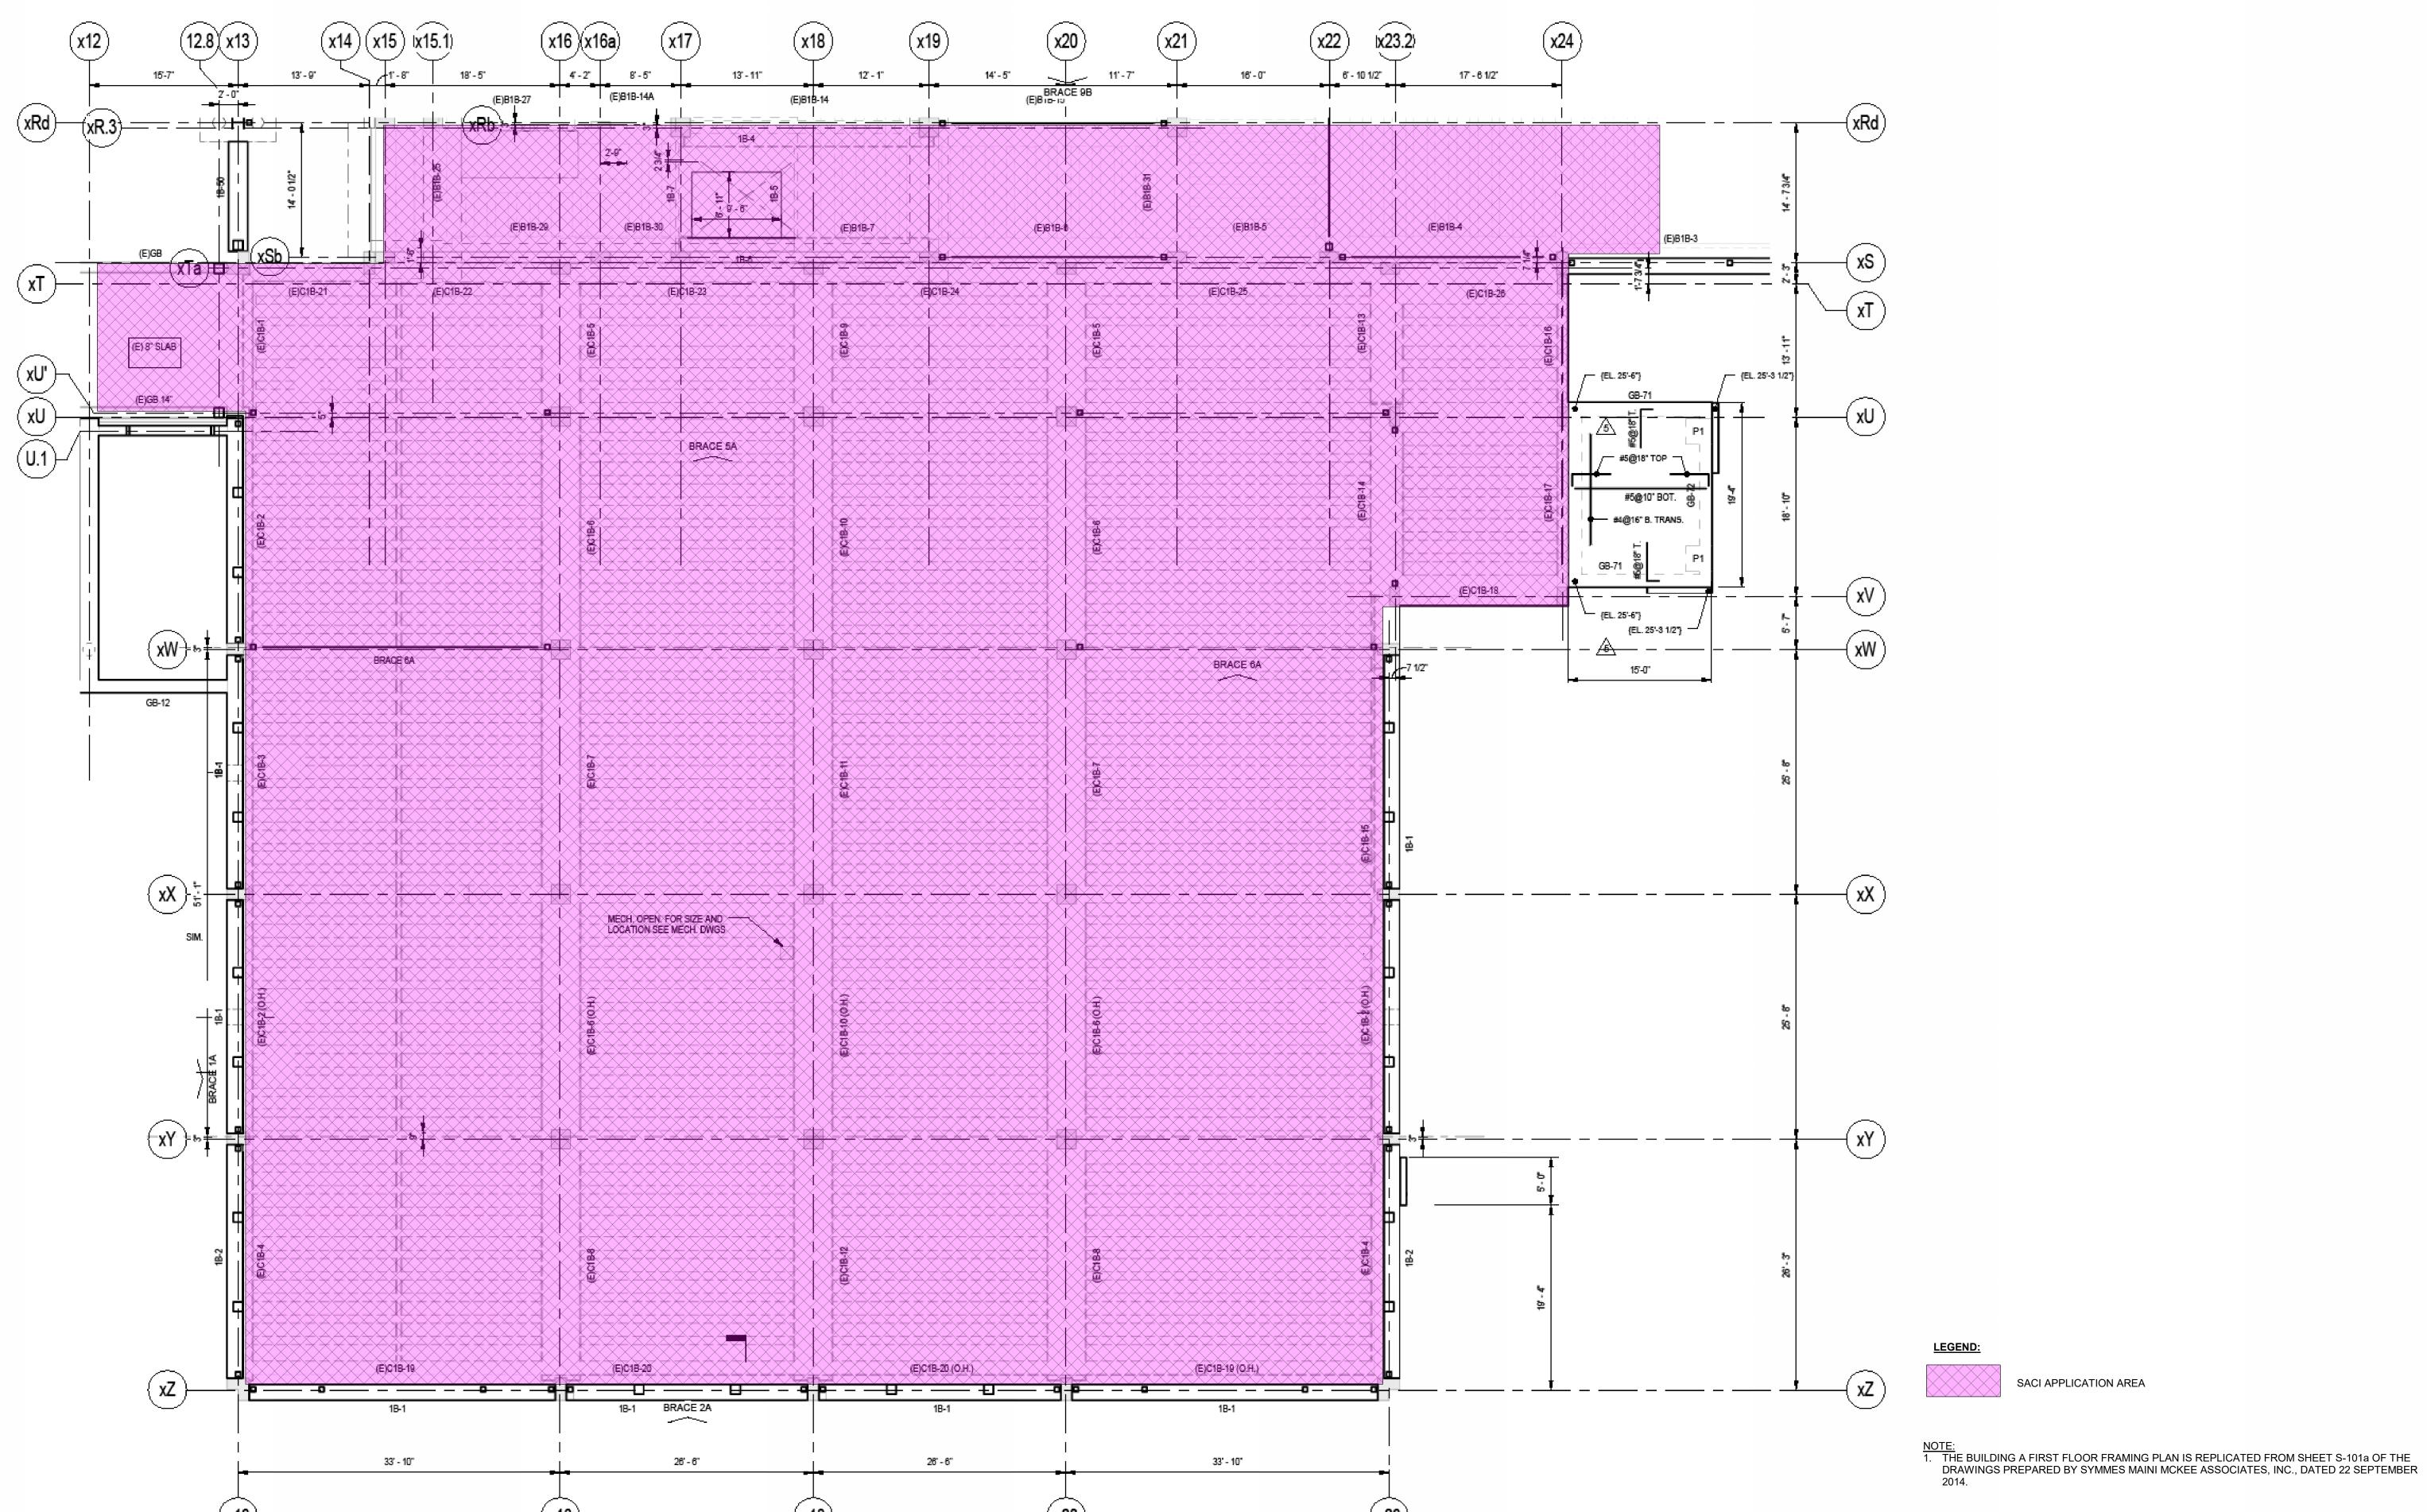
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BASEMENT LEVEL ACCESSIBILITY PLAN

Drawing Title

S10²



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Description

INHIBITOR

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Proje

SACI PLAN -BUILDING A

Drawing

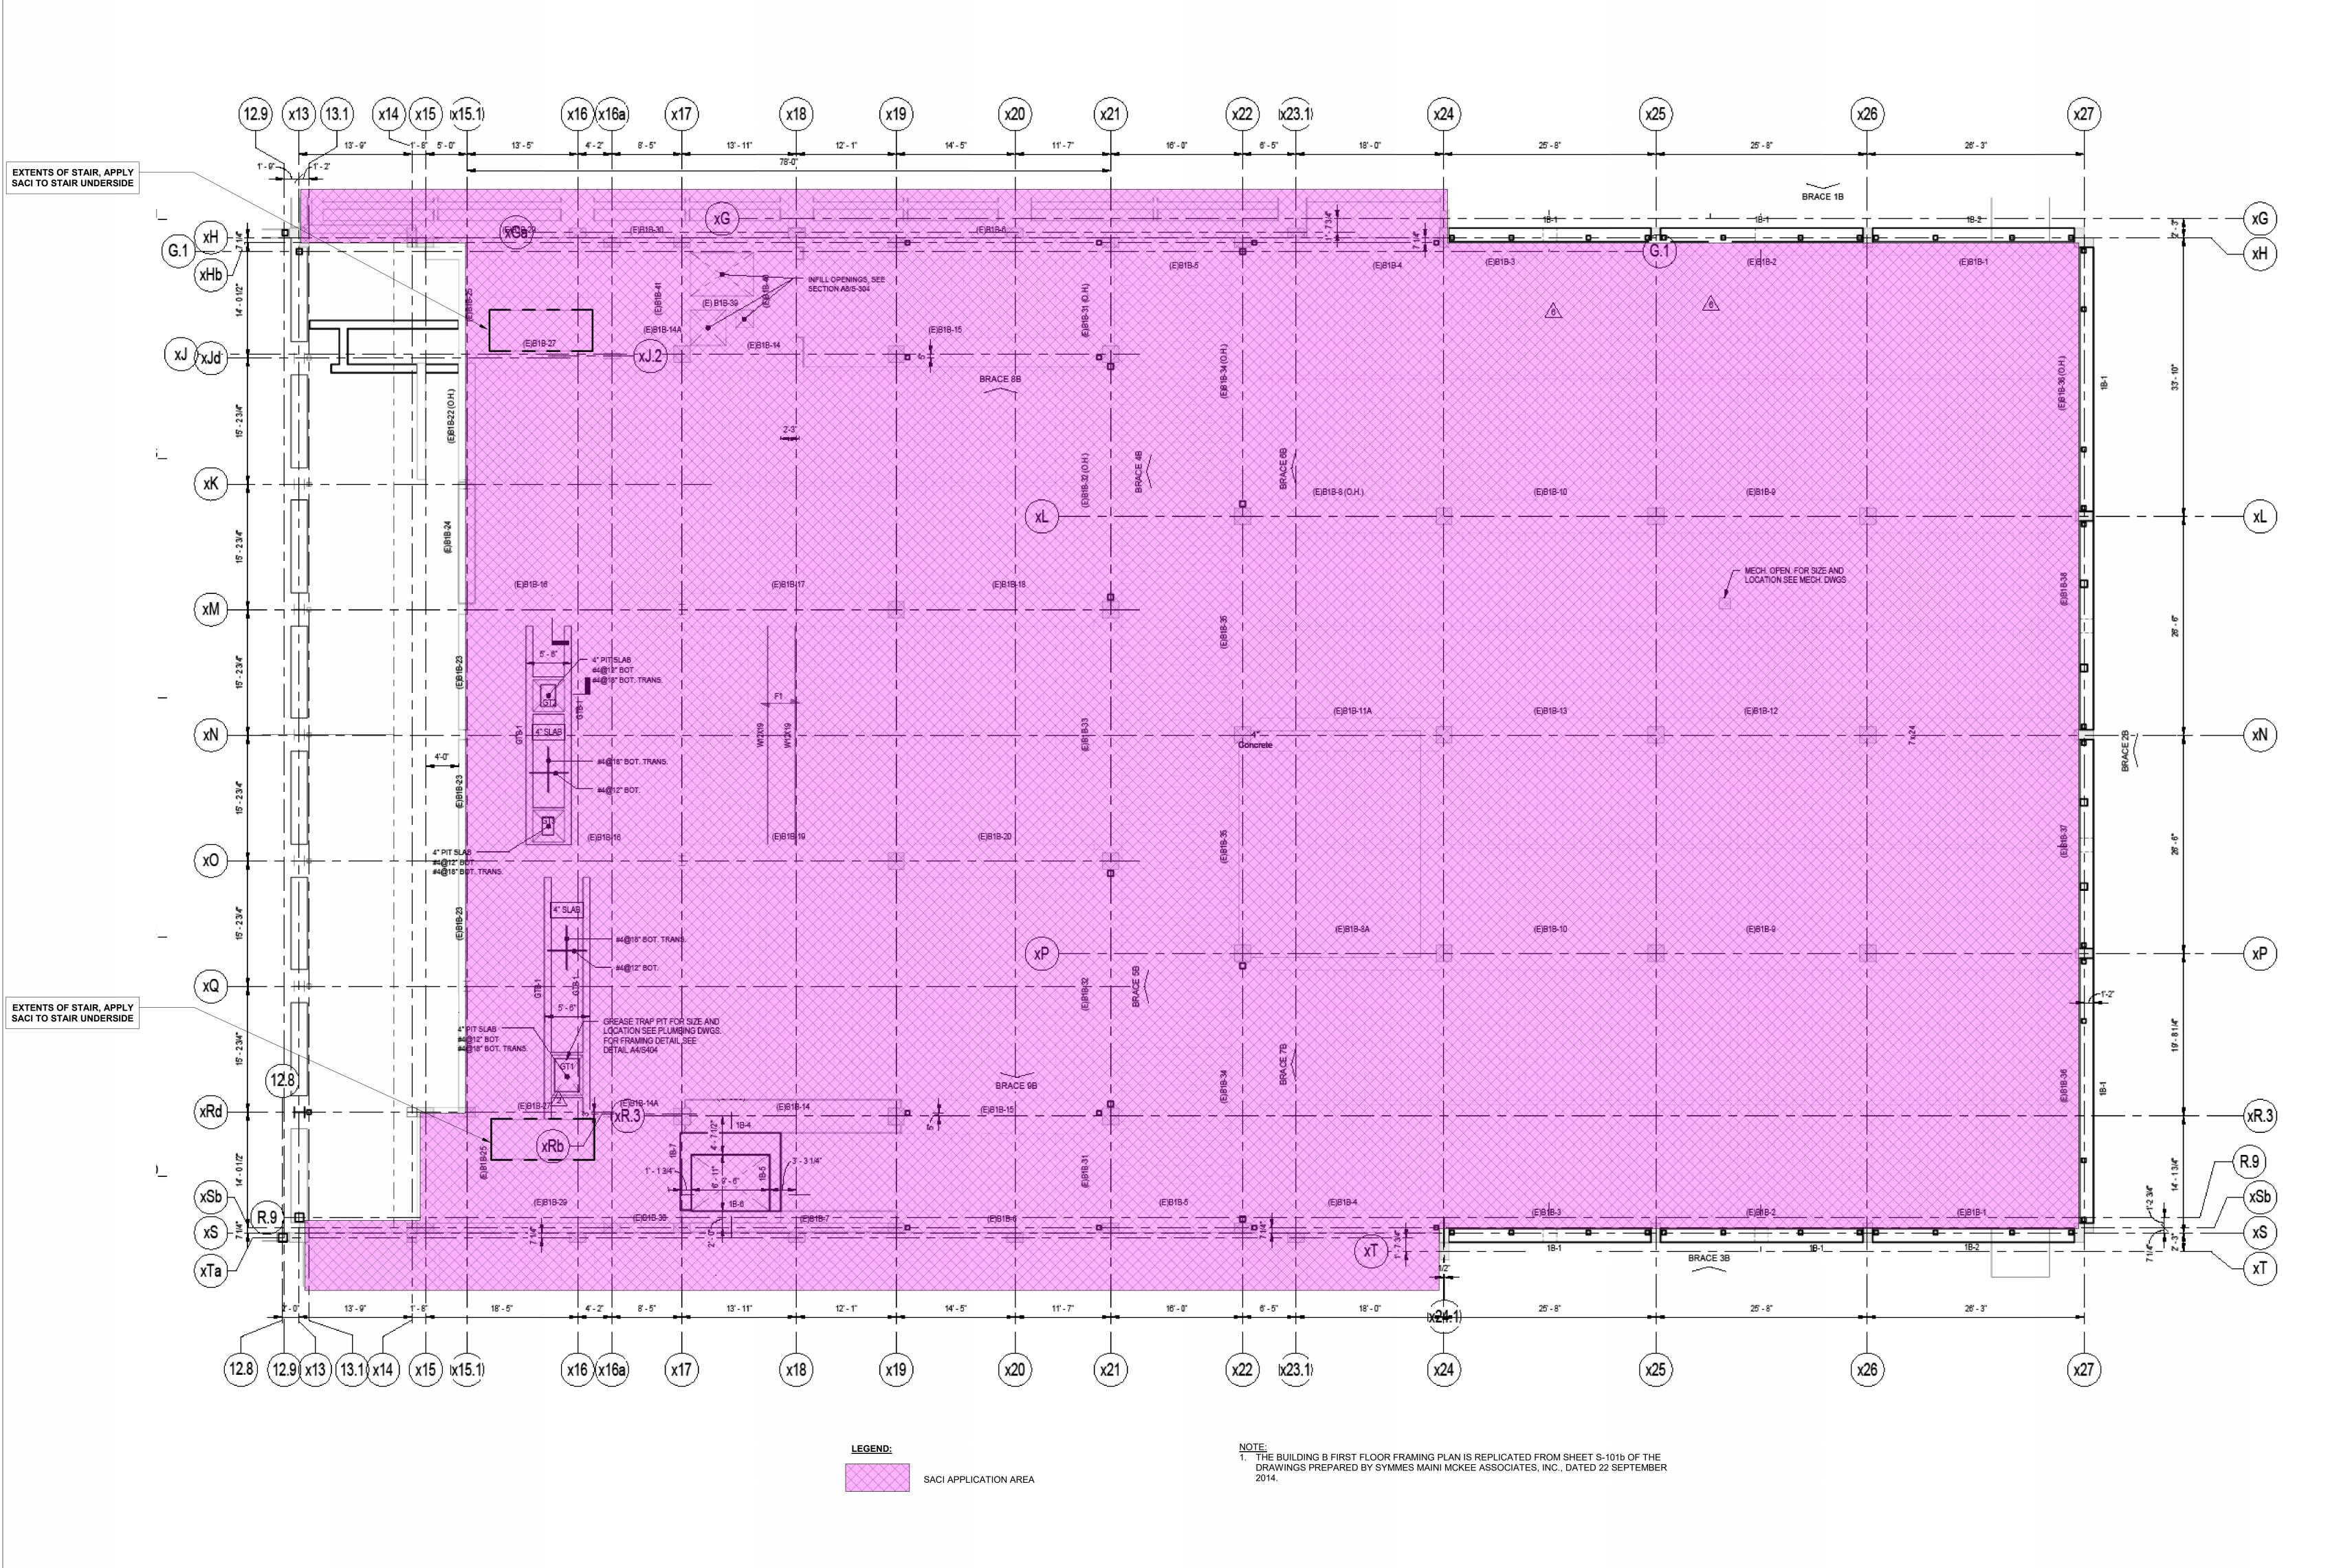
	Project No. 231066.04	Checked JAG	Date 02/21/25	
	Drawn SPC	Approved GGC	Scale As indicated	
			Drawing No.	

S200

SURFACE APPLIED CORROSION INHIBITOR PLAN - BUILDING A

1/8" = 1'-0"

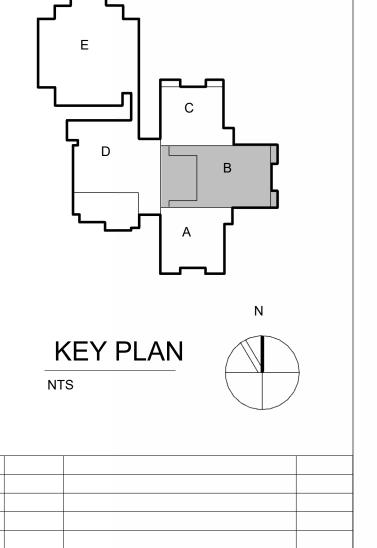
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Consultant

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WINCHESTER HIGH SCHOOL SURFACE APPLIED CORROSION INHIBITOR

Description

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Projec

SACI PLAN -BUILDING B

Drawing Title

Seal

Project No.
231066.04

Date
02/21/25

Drawn
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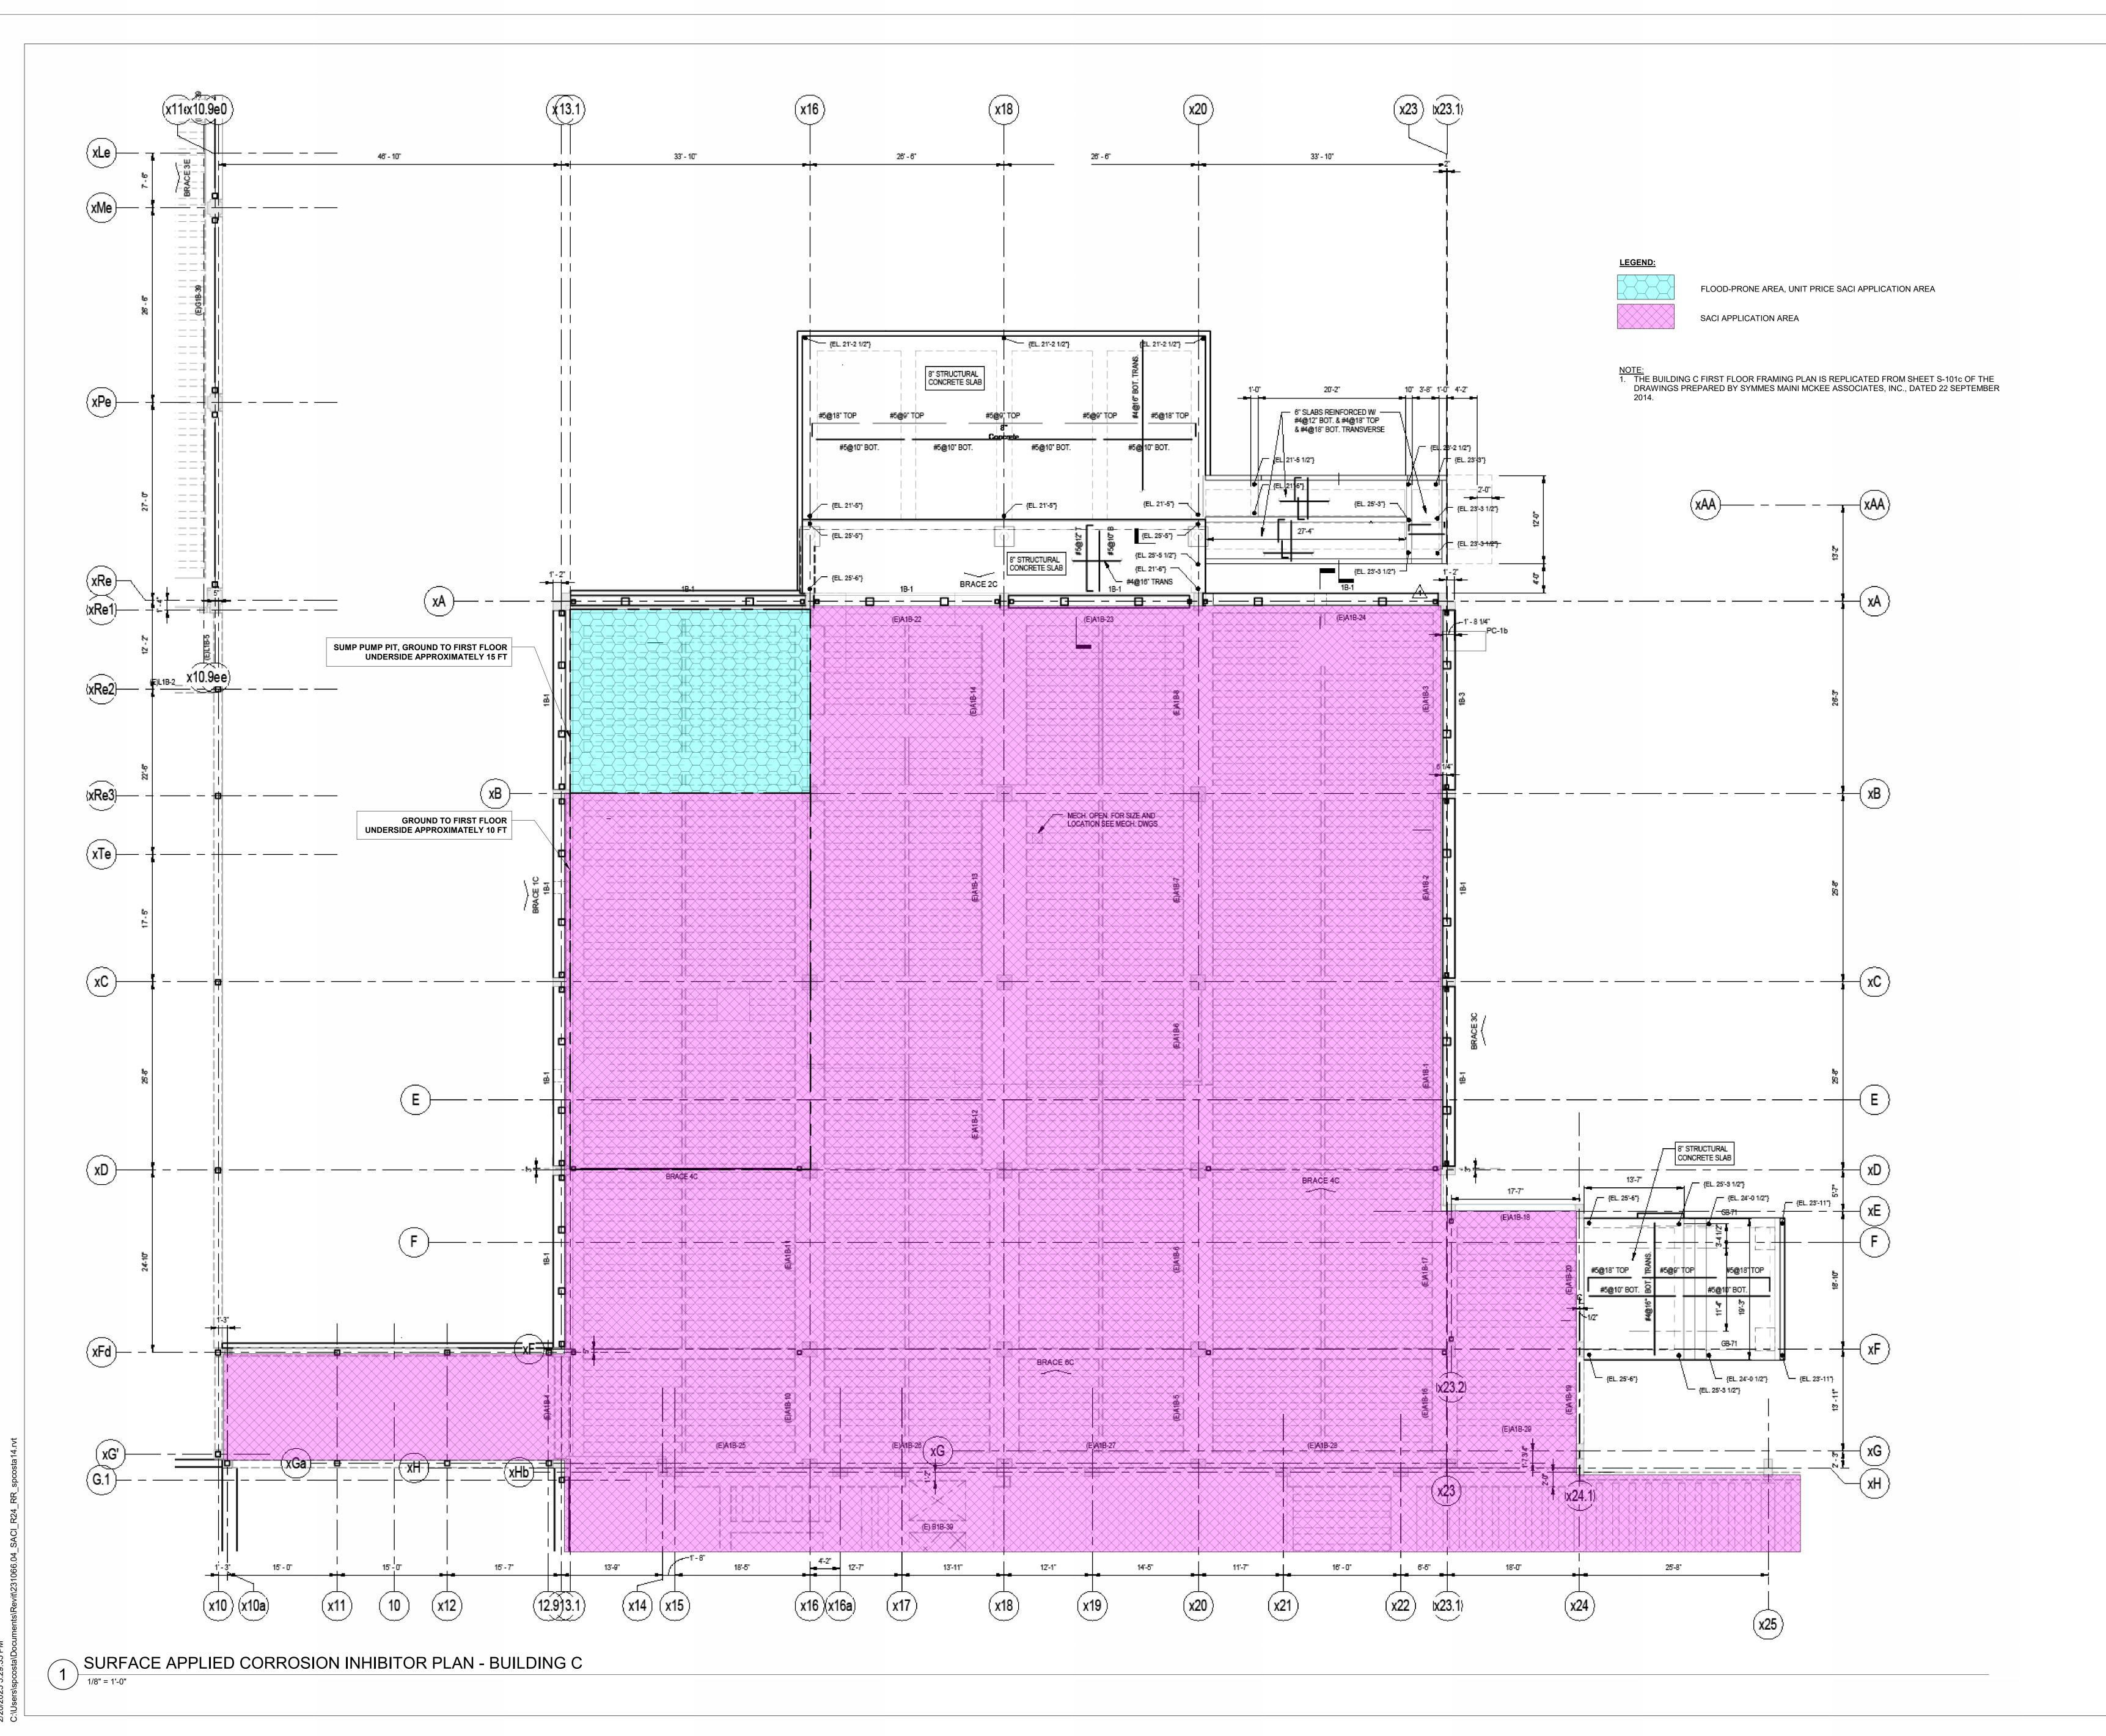
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S201

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SURFACE APPLIED CORROSION INHIBITOR PLAN - BUILDING B

1/8" = 1'-0"



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KEY PLAN

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WINCHESTER HIGH SCHOOL SURFACE APPLIED CORROSION INHIBITOR

Description

80 Skillings Road Winchester, MA 01890

Project

SACI PLAN -BUILDING C

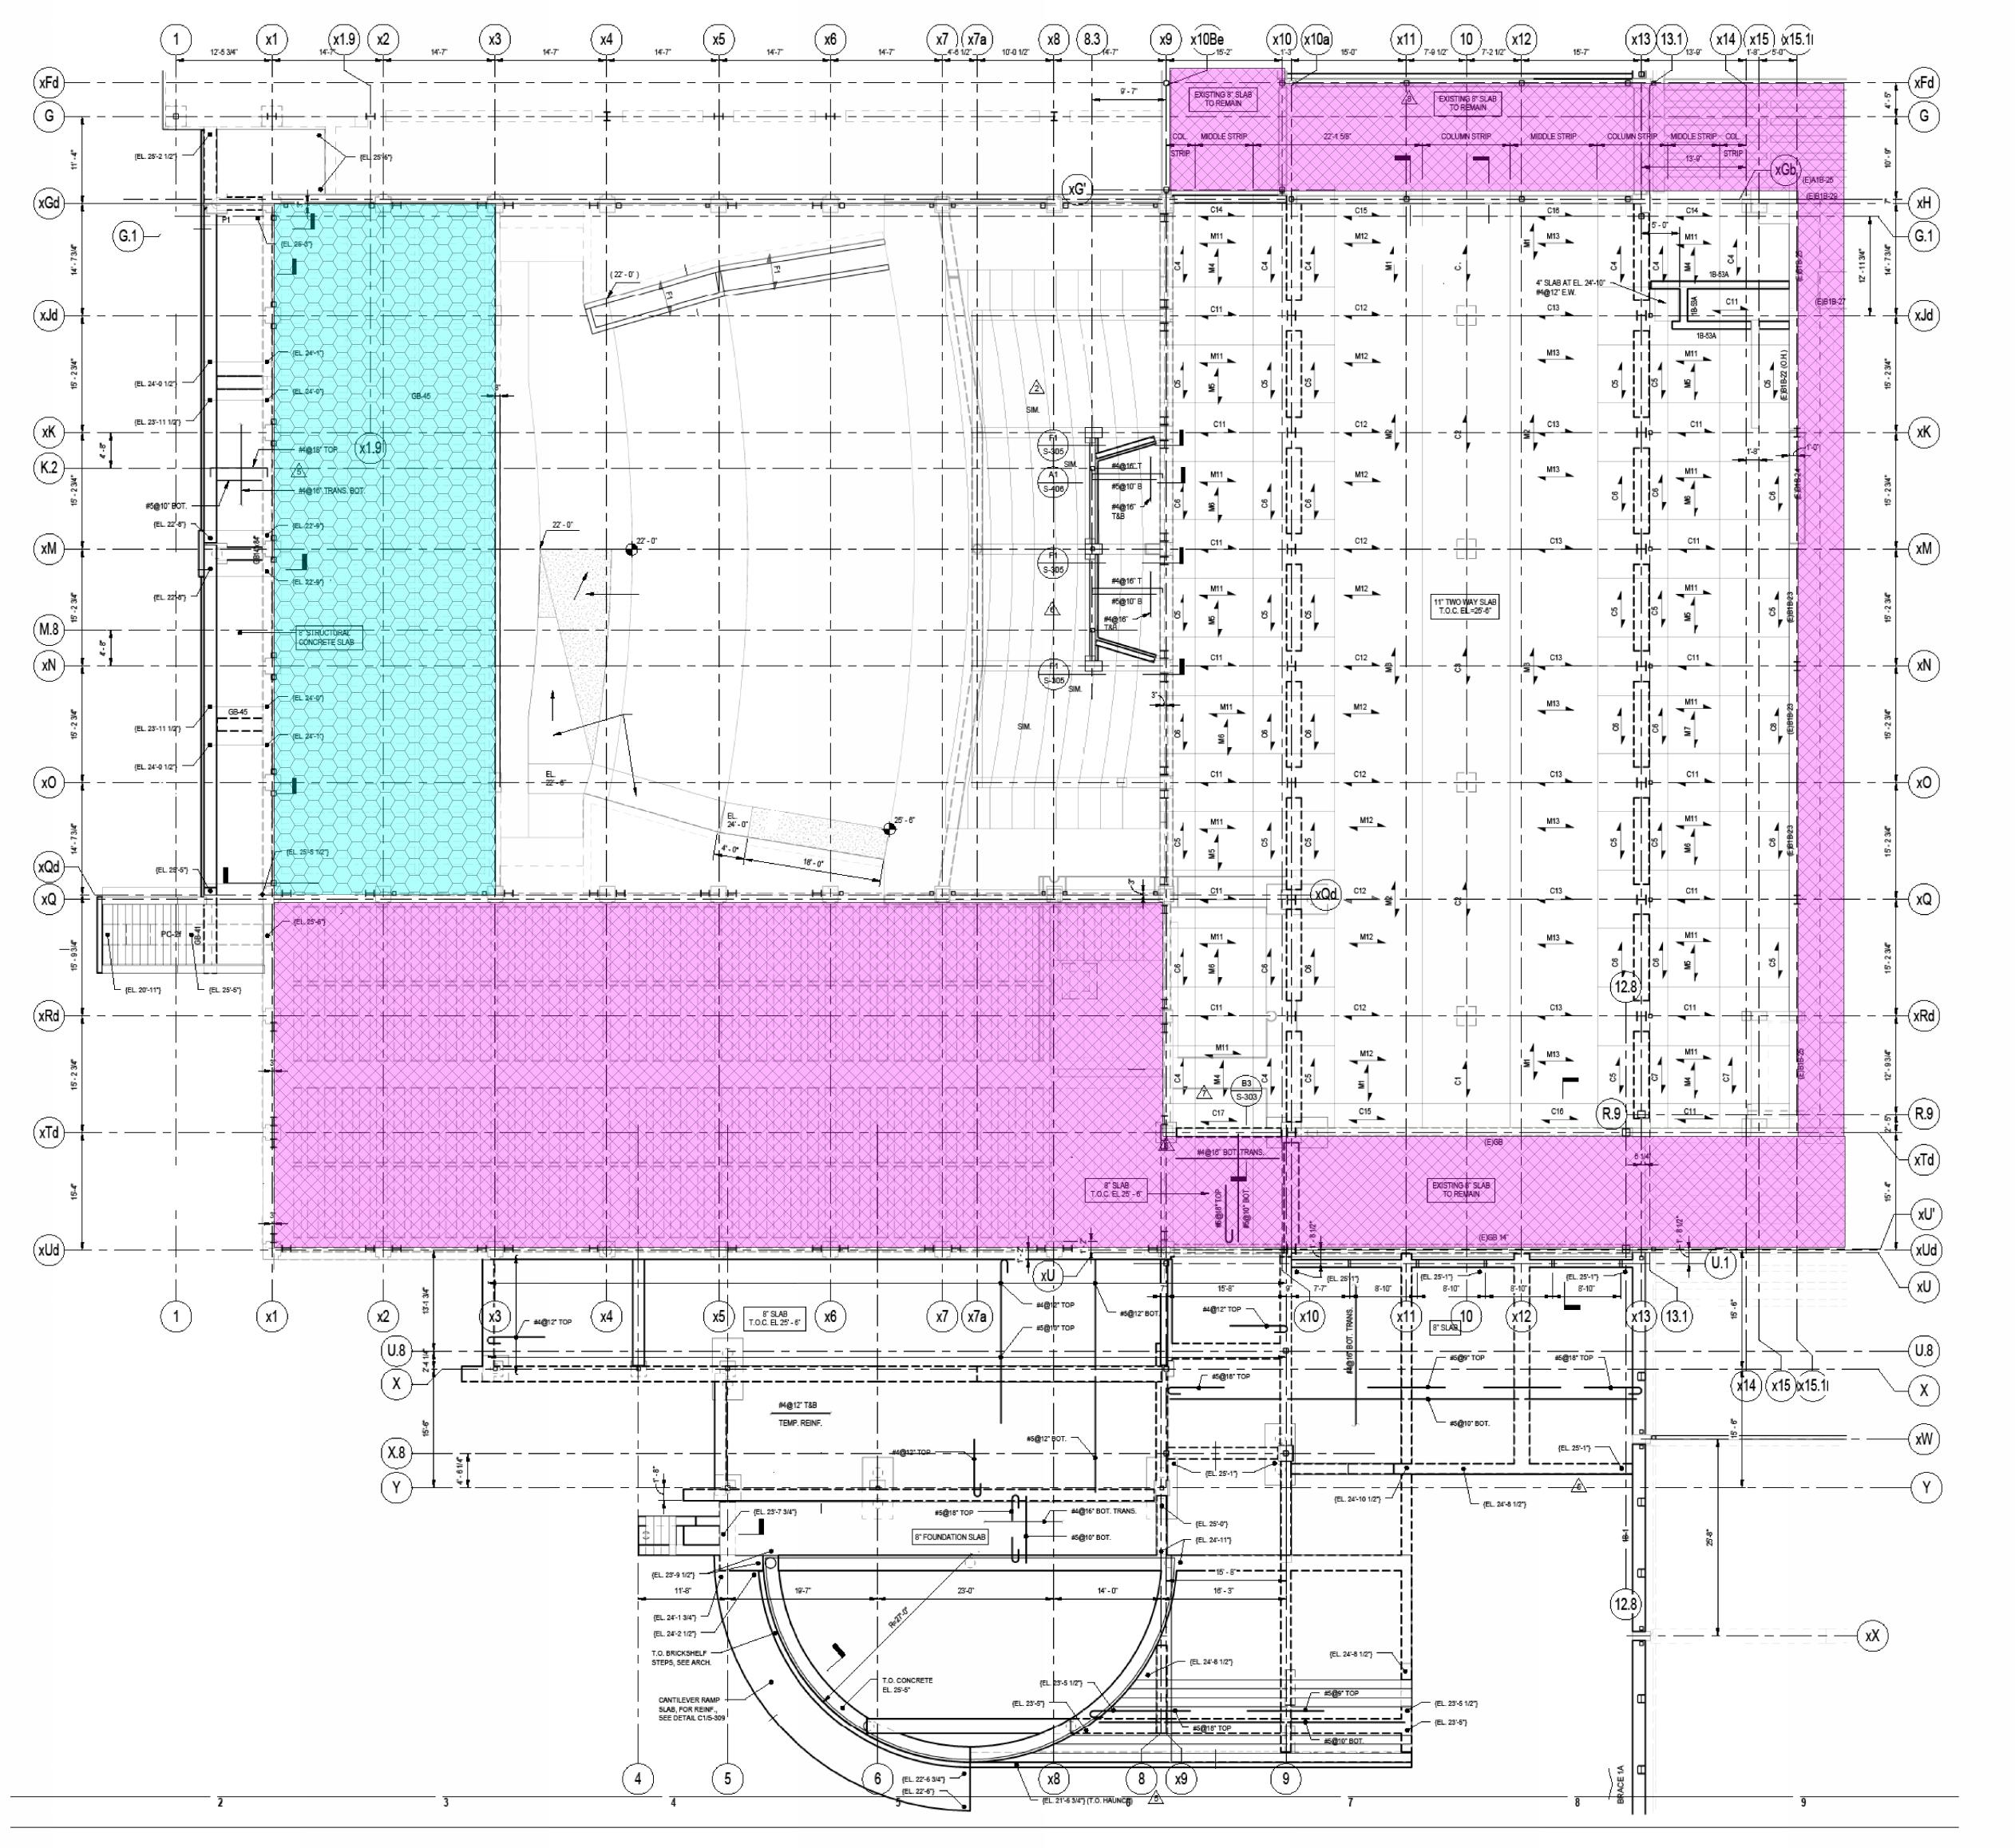
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Project No.
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231066.04 JAG 02/XX/25

Drawn Approved Scale
SPC GGC As indicated

Drawing No.

S202



LEGEND:

FLOOD-PRONE AREA, UNIT PRICE SACI APPLICATION AREA

SACI APPLICATION AREA

NOTE:

1. THE BUILDING D FIRST FLOOR FRAMING PLAN IS REPLICATED FROM SHEET S-101d OF THE DRAWINGS PREPARED BY SYMMES MAINI MCKEE ASSOCIATES, INC., DATED 22 SEPTEMBER

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KEY PLAN

No. Date Description

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SACI PLAN -BUILDING D

Drawing Title

Seal

Project No.
231066.04

Date
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SPC

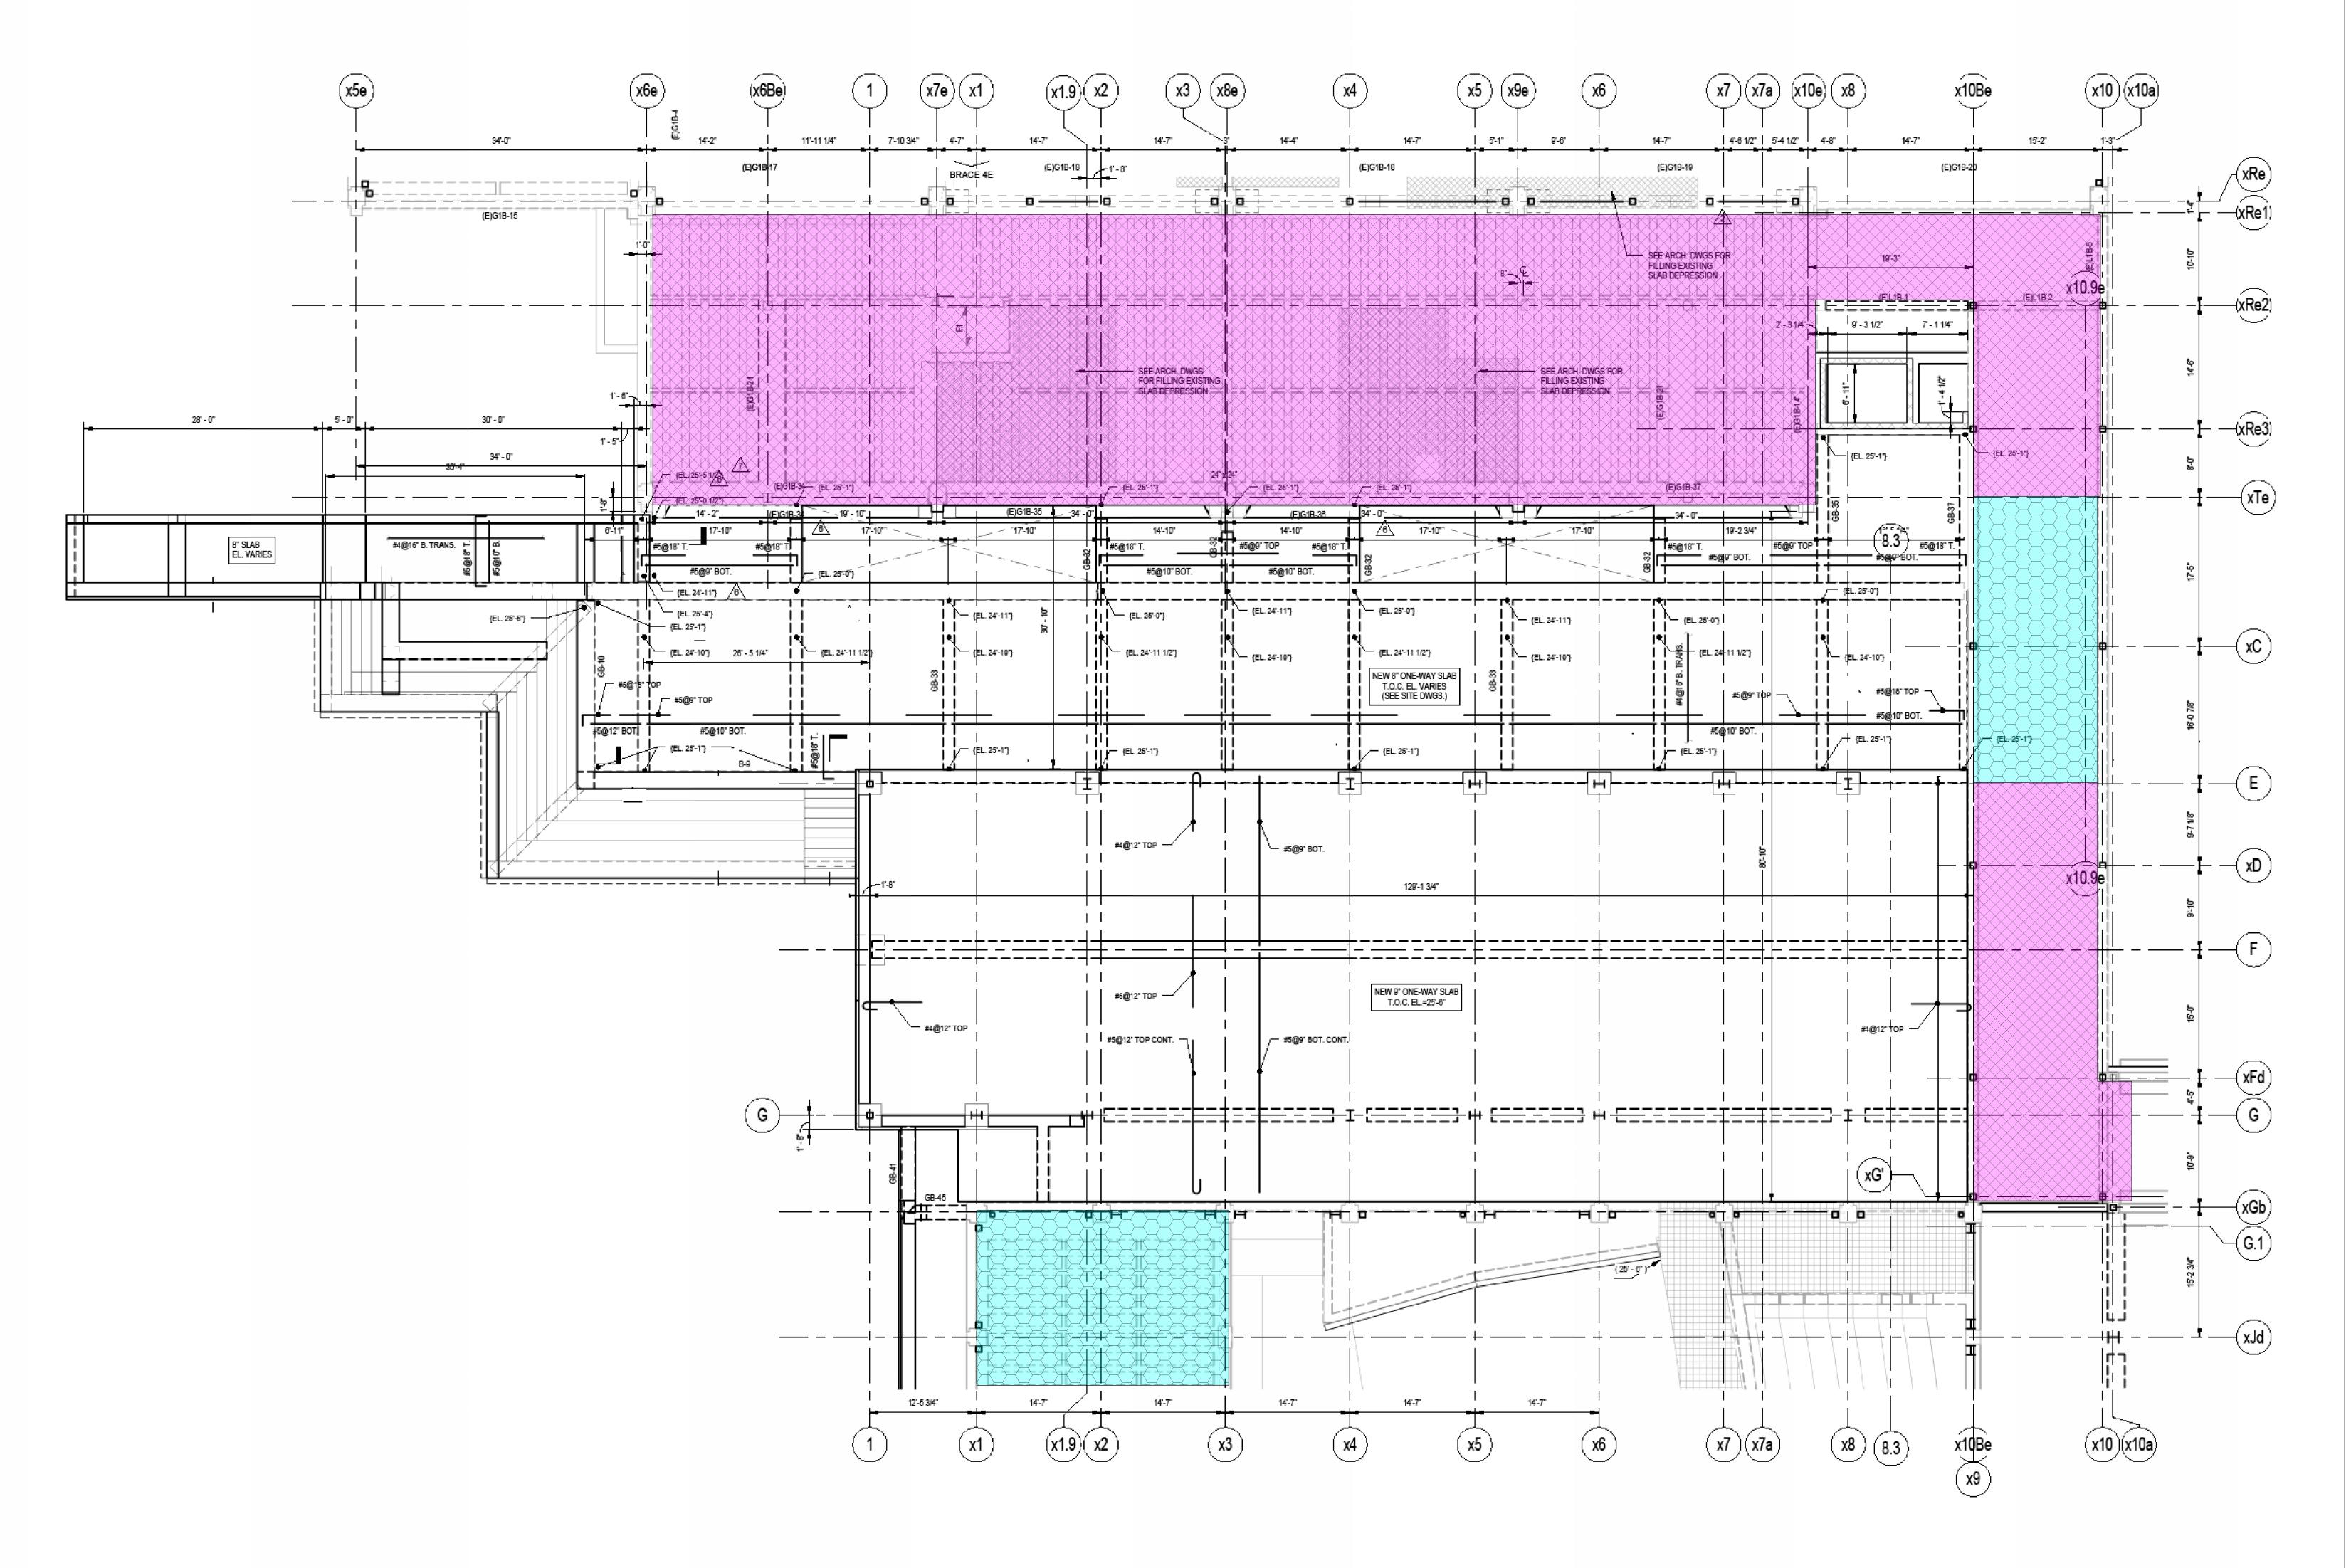
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GGC

Drawing No.

S203

SURFACE APPLIED CORROSION INHIBITOR PLAN - BUILDING D

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FLOOD-PRONE AREA, UNIT PRICE SACI APPLICATION AREA

SACI APPLICATION AREA

NOTE:

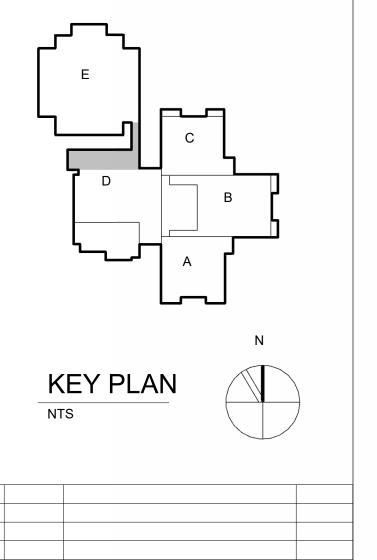
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Description

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Project

SACI PLAN -BUILDING D/E

Drawing Title

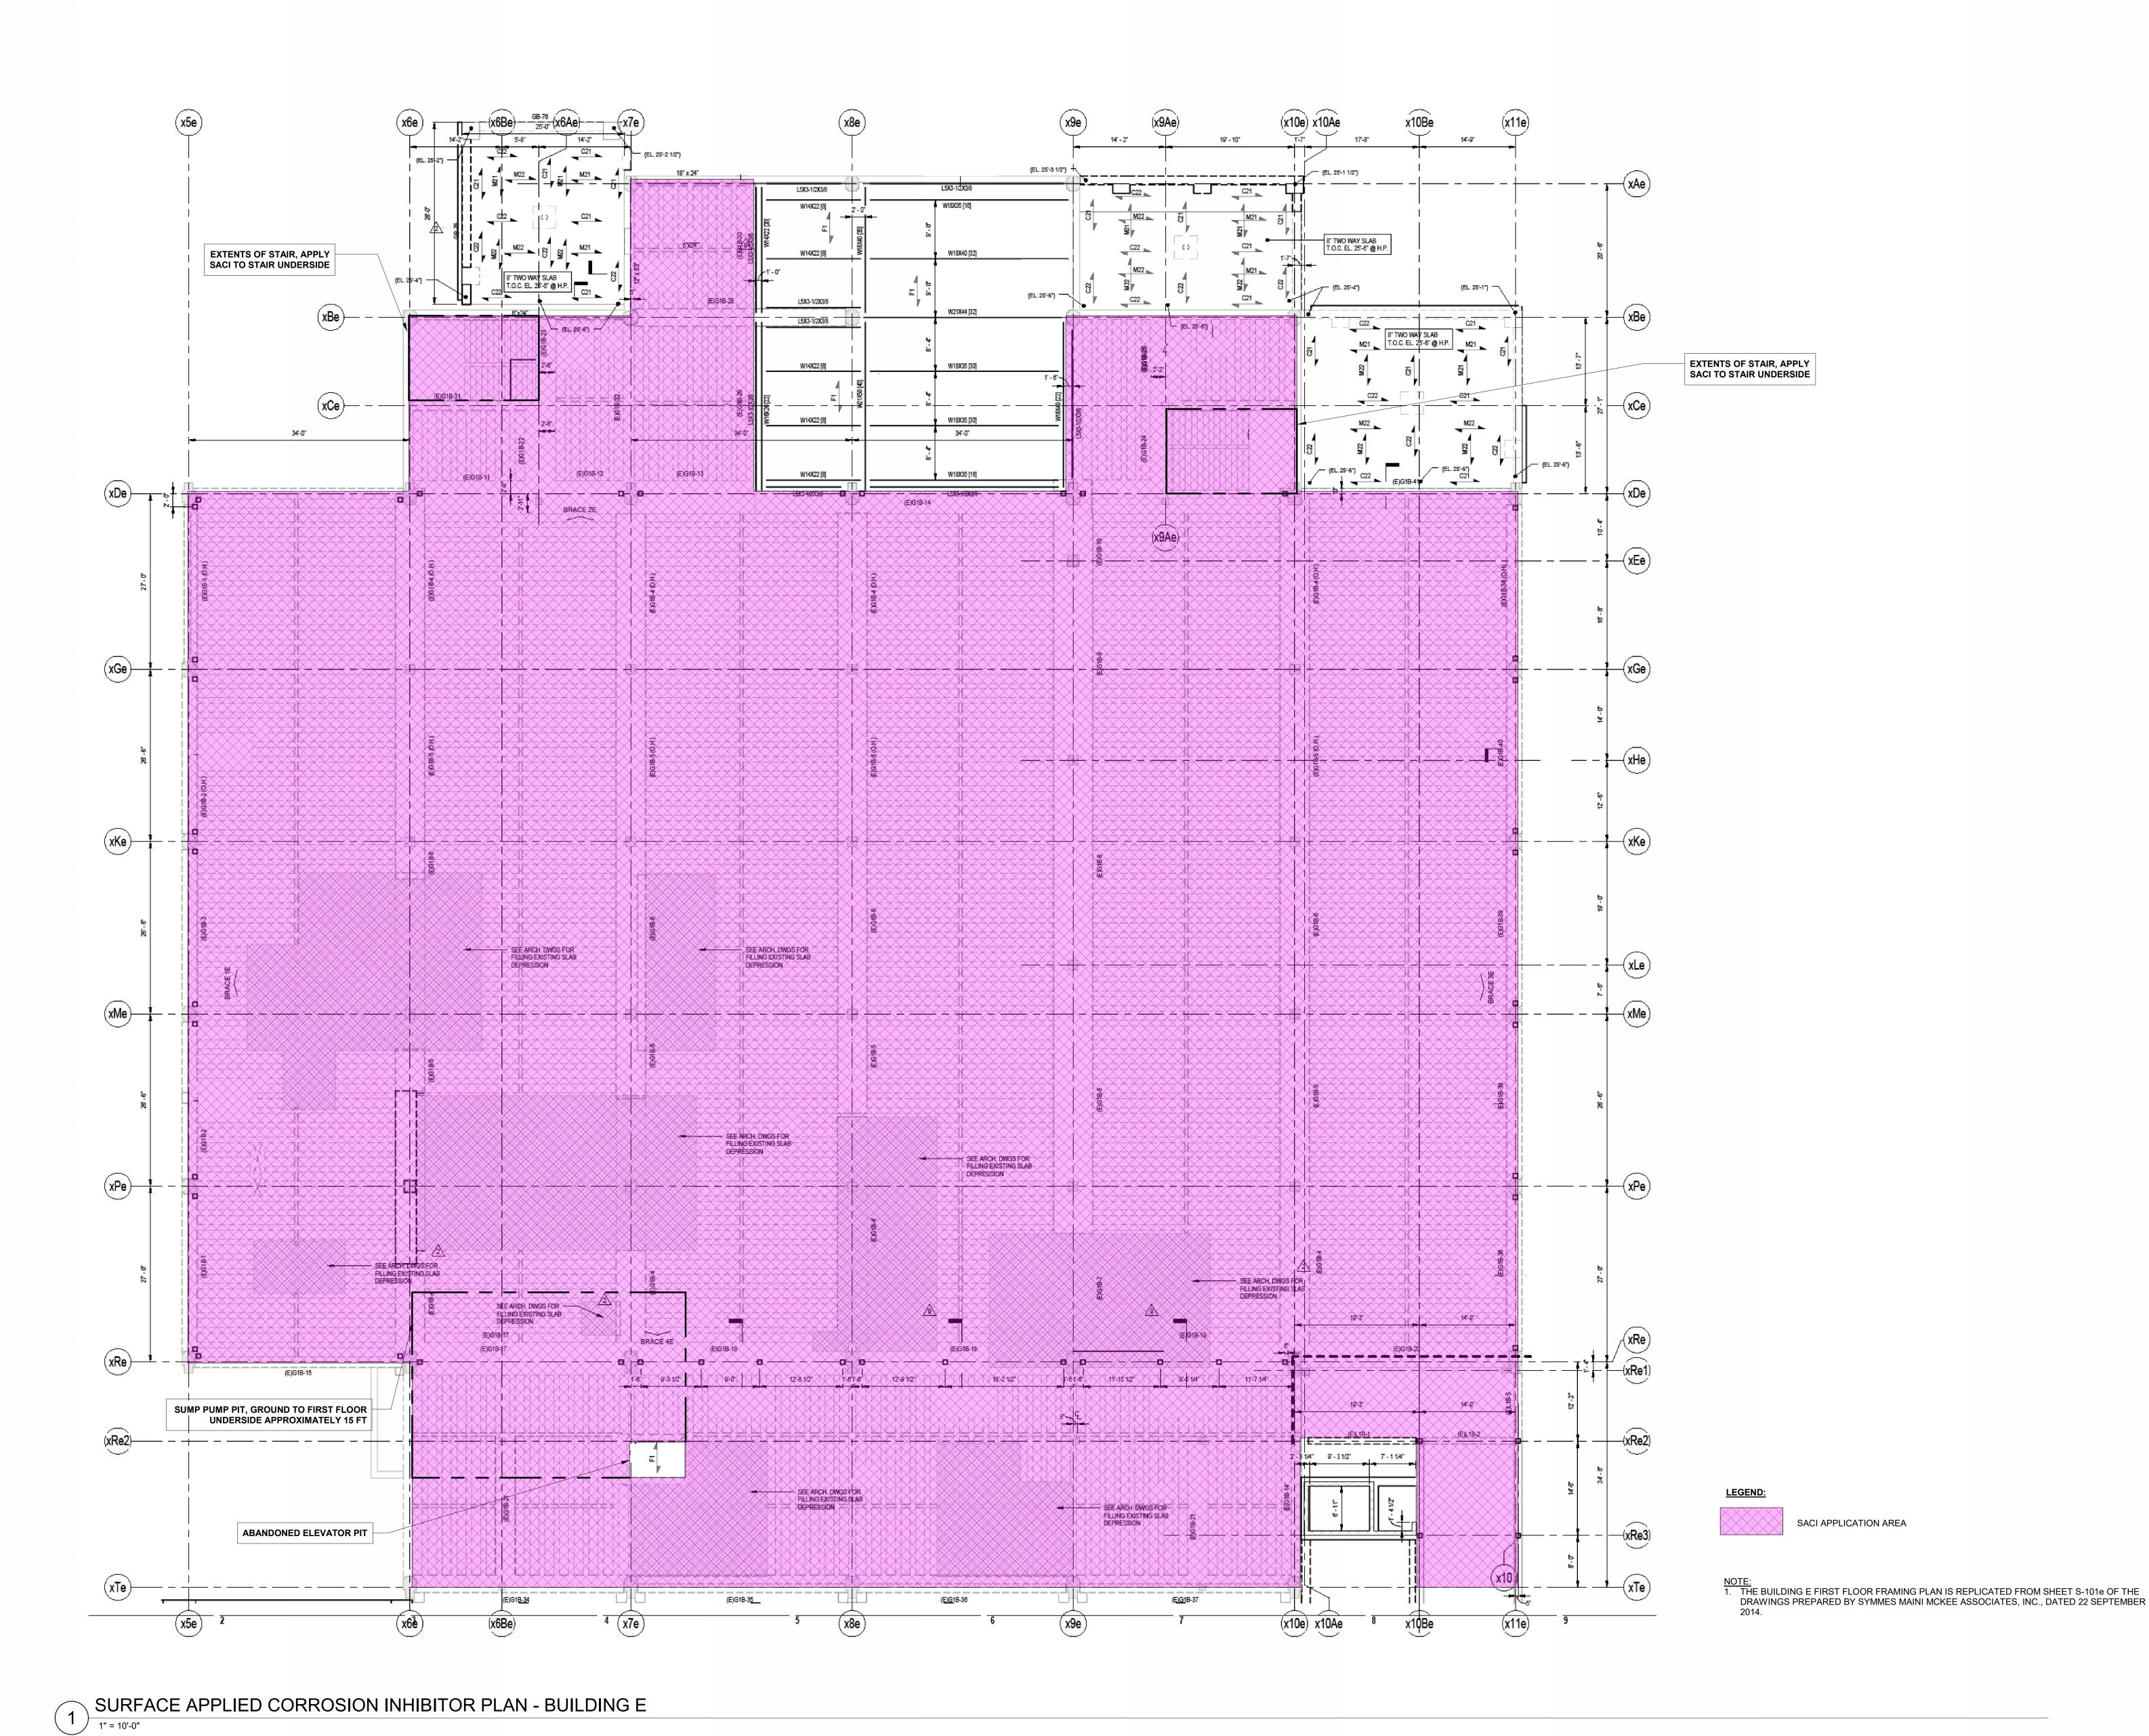
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Drawing No.

S204



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KEY PLAN

Description

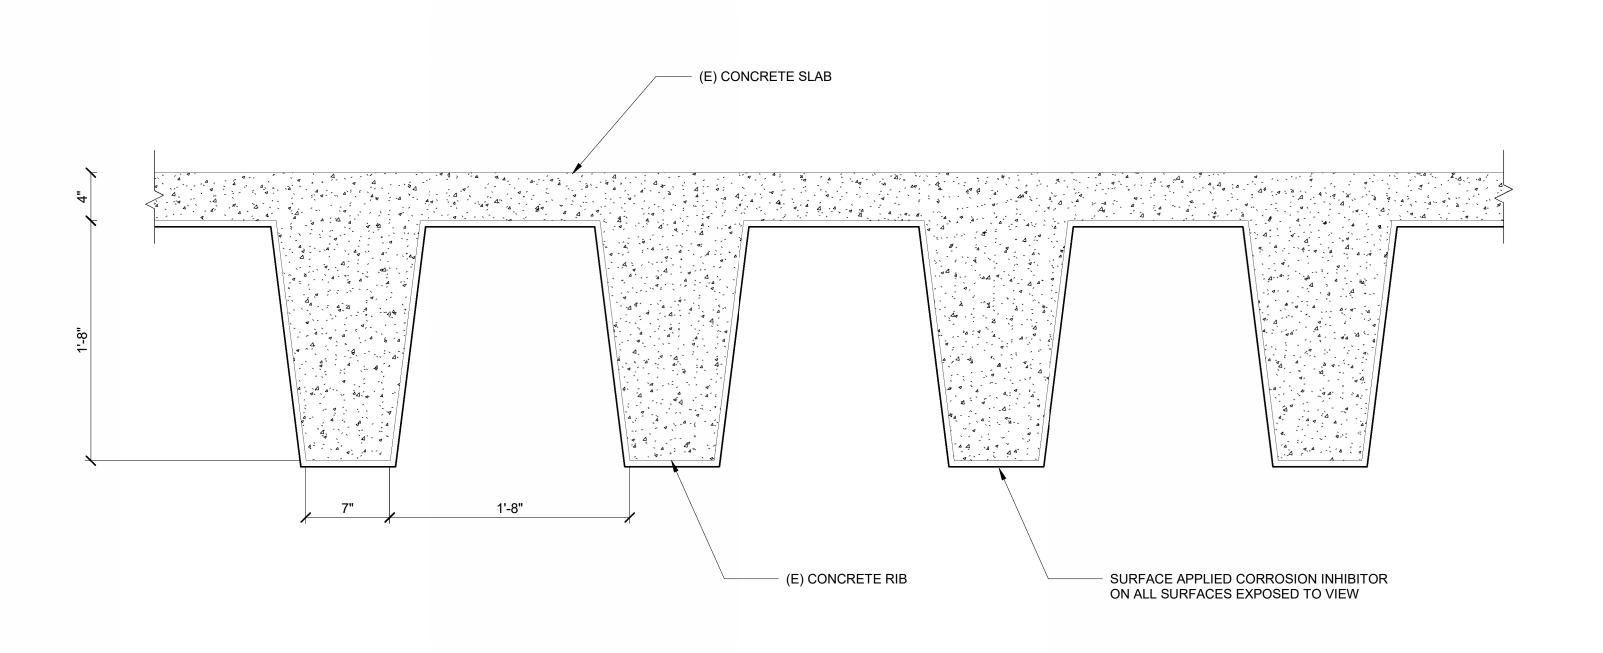
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SACIPLAN -**BUILDING E**

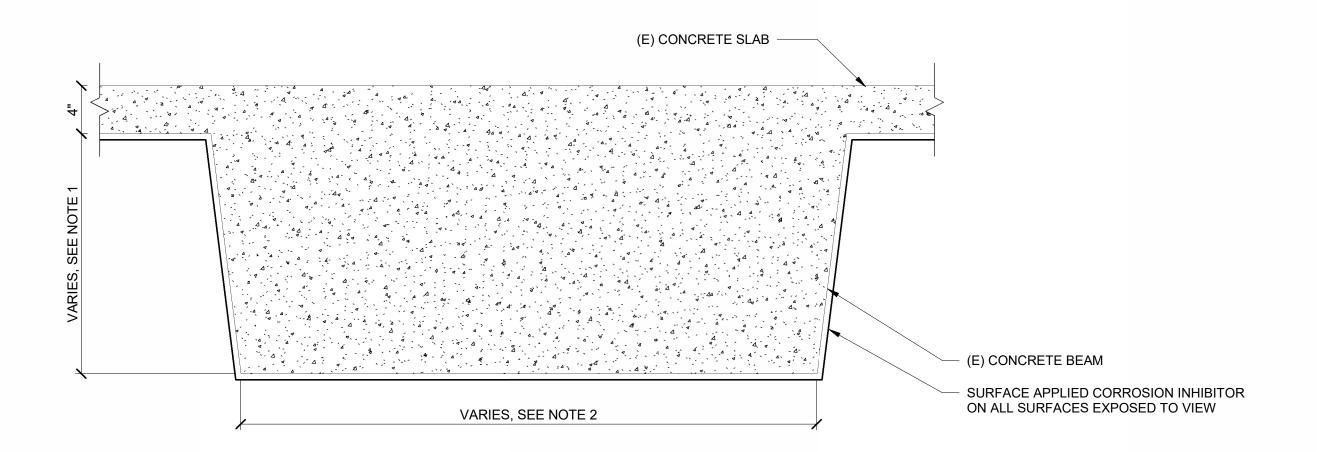
Drawing Title

Project No. 231066.04 02/21/25 Approved GGC As indicated Drawing No.



TYPICAL SURFACE APPLIED CORROSION INHIBITOR DETAIL

1 1/2" = 1'-0"



TYPICAL BAY BEAM HEIGHT IS 24 IN BUT VARIES FROM 24 IN TO 60 IN THROUGHOUT FIRST FLOOR FRAMING.
 TYPICAL BAY BEAM WIDTH IS 48 IN BUT VARIES FROM 12 IN TO 72 IN THROUGHOUT FIRST FLOOR FRAMING.

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TYPICAL SACI **DETAIL**

Date 02/XX/2025 Scale 1 1/2" = 1'-0" Drawing No.